



WALL TYPES

- ① 1/2" PLYWOOD SHEATHING
2x6 STUD WALL 16" O.C.
W/ BATT INSULATION
1/2" TYPE X GYPSUM BOARD
- ② 8" CONCRETE WALL
2x4
- ③ 10" CONCRETE WALL
2x4 STUD WALL 16" O.C.
W/ BATT INSULATION
1/2" TYPE X GYPSUM BOARD
- ④ 1/2" TYPE X GYPSUM BOARD
2x4 STUD WALL 16" O.C. W/
SOUNDATTENUATION (INSULATE
ALL INTERIOR WALLS EXCEPT
CLOSETS) IN APTS)
- ⑤ 5/8" TYPE X GYPSUM BOARD
2x6 STUD WALL 16" O.C.
W/ BATT INSULATION
- ⑥ 5/8" TYPE X GYPSUM BOARD
1/2" SOUNDBOARD - APT SIDE
- ⑦ 5/8" TYPE X GYPSUM BOARD
1/2" RESILIENT CHANNEL
1/2" SOUNDBOARD
SOUND ATTEN. BLANKET
2x4 STUD WALL 16" O.C.
1 1/8" GAP
1/2" SOUNDBOARD
- ⑧ 8" CONCRETE WALL
2x4 STUD WALL 16" O.C.
W/ BATT INSULATION
1/2" TYPE X GYPSUM BOARD
- ⑨ 1/2" TYPE X GYPSUM BOARD
2x6 STUD WALL 16" O.C.
W/ BATT INSULATION
1/2" TYPE X GYPSUM BOARD
- ⑩ 1/2" TYPE X GYPSUM BOARD
2x4 STUD WALL 16" O.C.
1/2" TYPE X GYPSUM BOARD

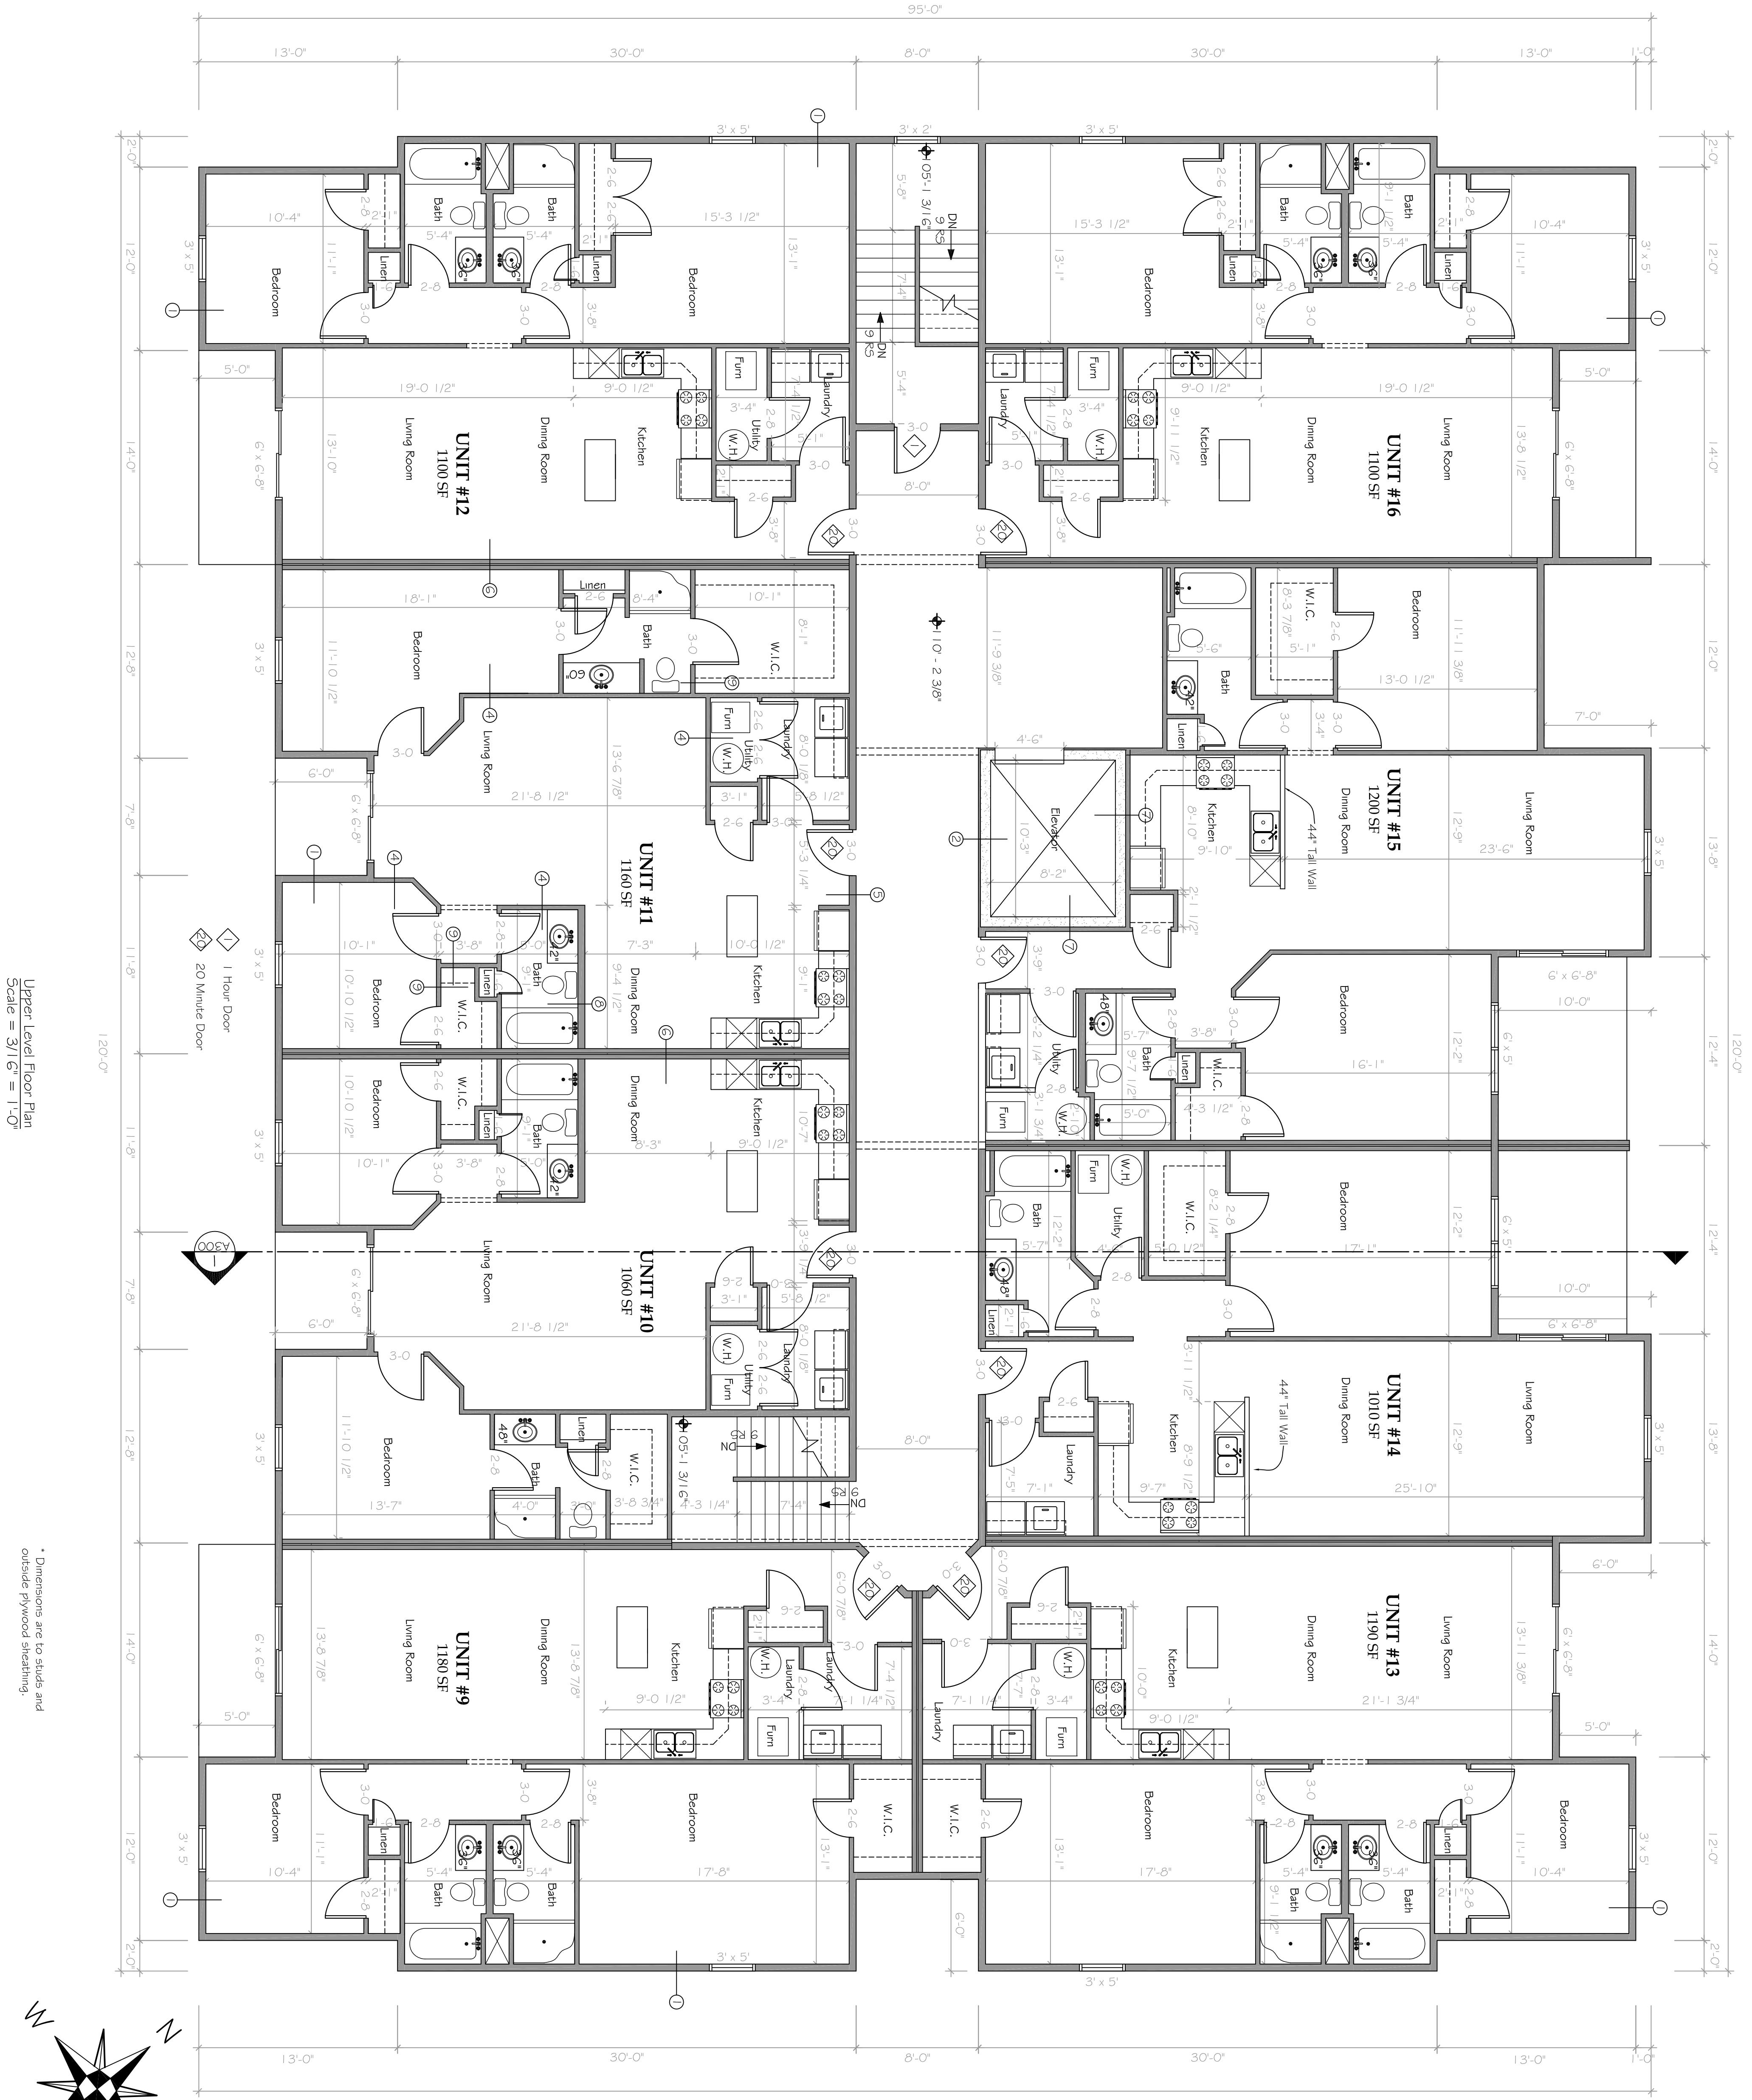

Upper Level Floor Plan
Scale = 3/16" = 1'-0"

* Dimensions are to studs and
outside plywood sheathing.

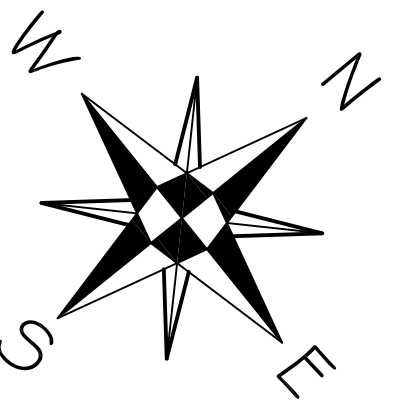

A102	Upper Level Floor Plan Grand Manor Apartments Pierre, South Dakota	Project #: Date: 1/12/08 Drawn By: R.V.D.	 CIAVARELLA DESIGN	322 East 1st Ave Mitchell, SD 57301 Ph: 605-996-3735 www.ciavarelladesign.com